

2020/00705/FUL

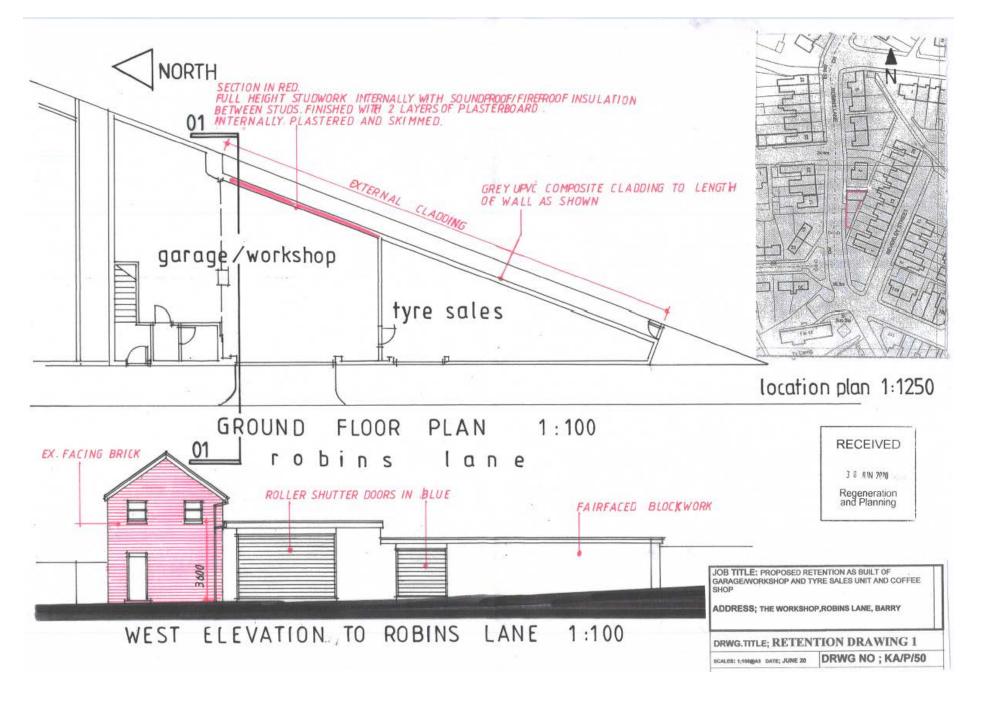

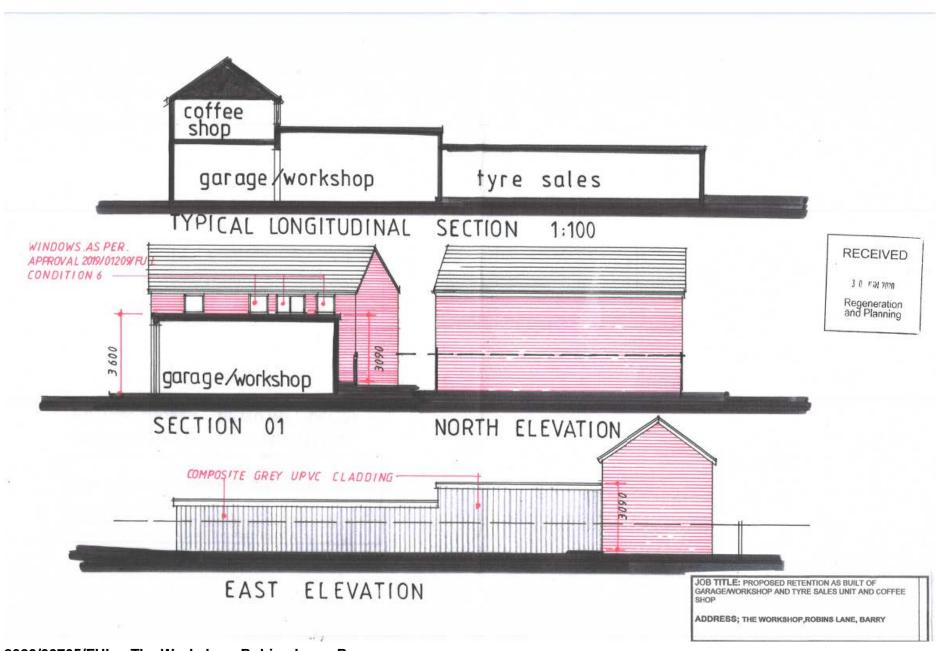

Site photograph 1 - The building prior to commencement of works



2020/00705/FUL - The Workshop, Robins Lane, Barry

Site photograph 2 – The building post completion



2020/00705/FUL - The Workshop, Robins Lane, Barry

Site photograph 3 – Street scene context



2020/00705/FUL – The Workshop, Robins Lane, Barry

Site photograph 4 - Front elevation




2020/00705/FUL – The Workshop, Robins Lane, Barry

Site photograph 5 - View from garden of No.9 Beverly Street (direction of No.11)




2020/00705/FUL - The Workshop, Robins Lane, Barry

Site photograph 6 – View from No.9 Beverly Street (direction of No.7)

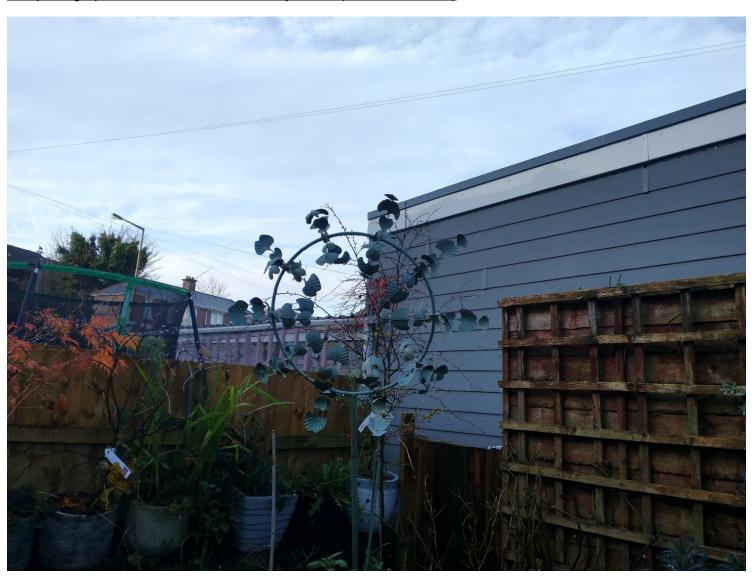

2020/00705/FUL - The Workshop, Robins Lane, Barry


Site photograph 7 – View from living room window of No.9 Beverley Street

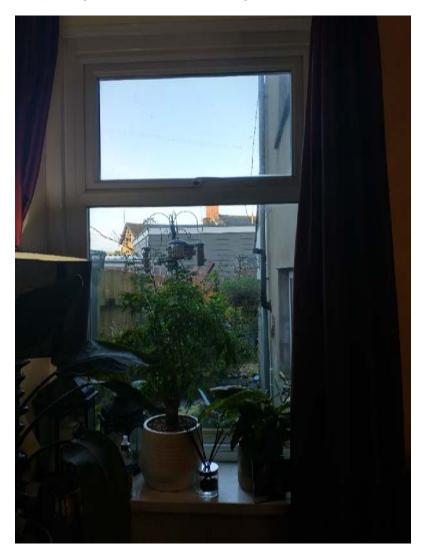

2020/00705/FUL - The Workshop, Robins Lane, Barry

Photographs from A Knight, 9 Beverly Street (21.07.20)

Photos showing the construction and impact of the increased roof height. There is an significant increase in height which, now exceeds the height of the fence at the rear of both Numbers 7 and 9 Beverley Street. Previously, the roof and supporting walls were not visible.

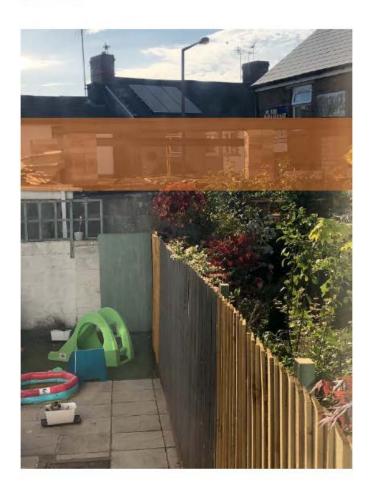


The increase in height is shown here with the shaded box.



Photographs from A. Knight, 9 Beverly Street (21.07.20)


Photos showing the construction and impact of the increased roof height. There is an significant visual and environmental impact, due to the decrease in the number of daylight hours. The unfinished roof shown here indicates how the finished roof and walls, directly block light entering the garden at Number 9 Beverley Street.



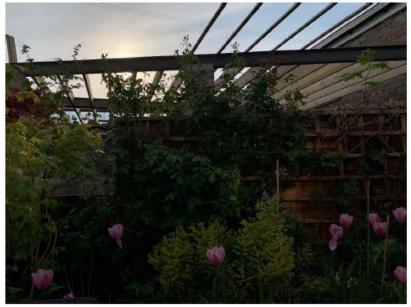

Photographs from A. Knight, 9 Beverly Street (21.07.20)

Photos showing the construction and impact of the increased roof height. There is an significant visual and environmental impact, regardless of whether the corrugated or cladding finish has been applied.

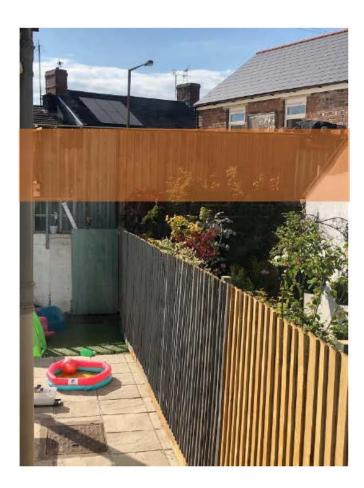

The increase in height is shown here with the shaded box.



Photographs from A. Knight, 9 Beverly Street (21.07.20)

Continued from the previous page. You can see the detrimental impact on the view from the Living Room at Number 9 Beverley Street, both in terms of reduced light and the visual impact.

The wall that can be seen from the window was a clear view to residential homes opposite, prior to the existing alterations.







100m

25m

VISUAL SCALE 1:1250 @ A3

50m

75m


NOTES

Do not scale this drawing.


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2019/01177/FUL



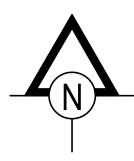

Aske Stables, Aske, Richmond, North Yorkshire. DL10 5HG t: 01748 825675 e: enquiries@harrisirwin.com

w: www.harrisirwin.com

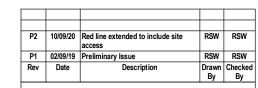Project:

Proposed Care Home Sanderstead Port Road Wenvoe CF5 6AB

Client:




Drawing Title: Location Plan

For Review and Comment

L			
	HIA Project Number	Scale @ A3	Suitability
	2306	1 · 1250	S3

2306 - HIA - ZZ - XX - DR - A - 01004



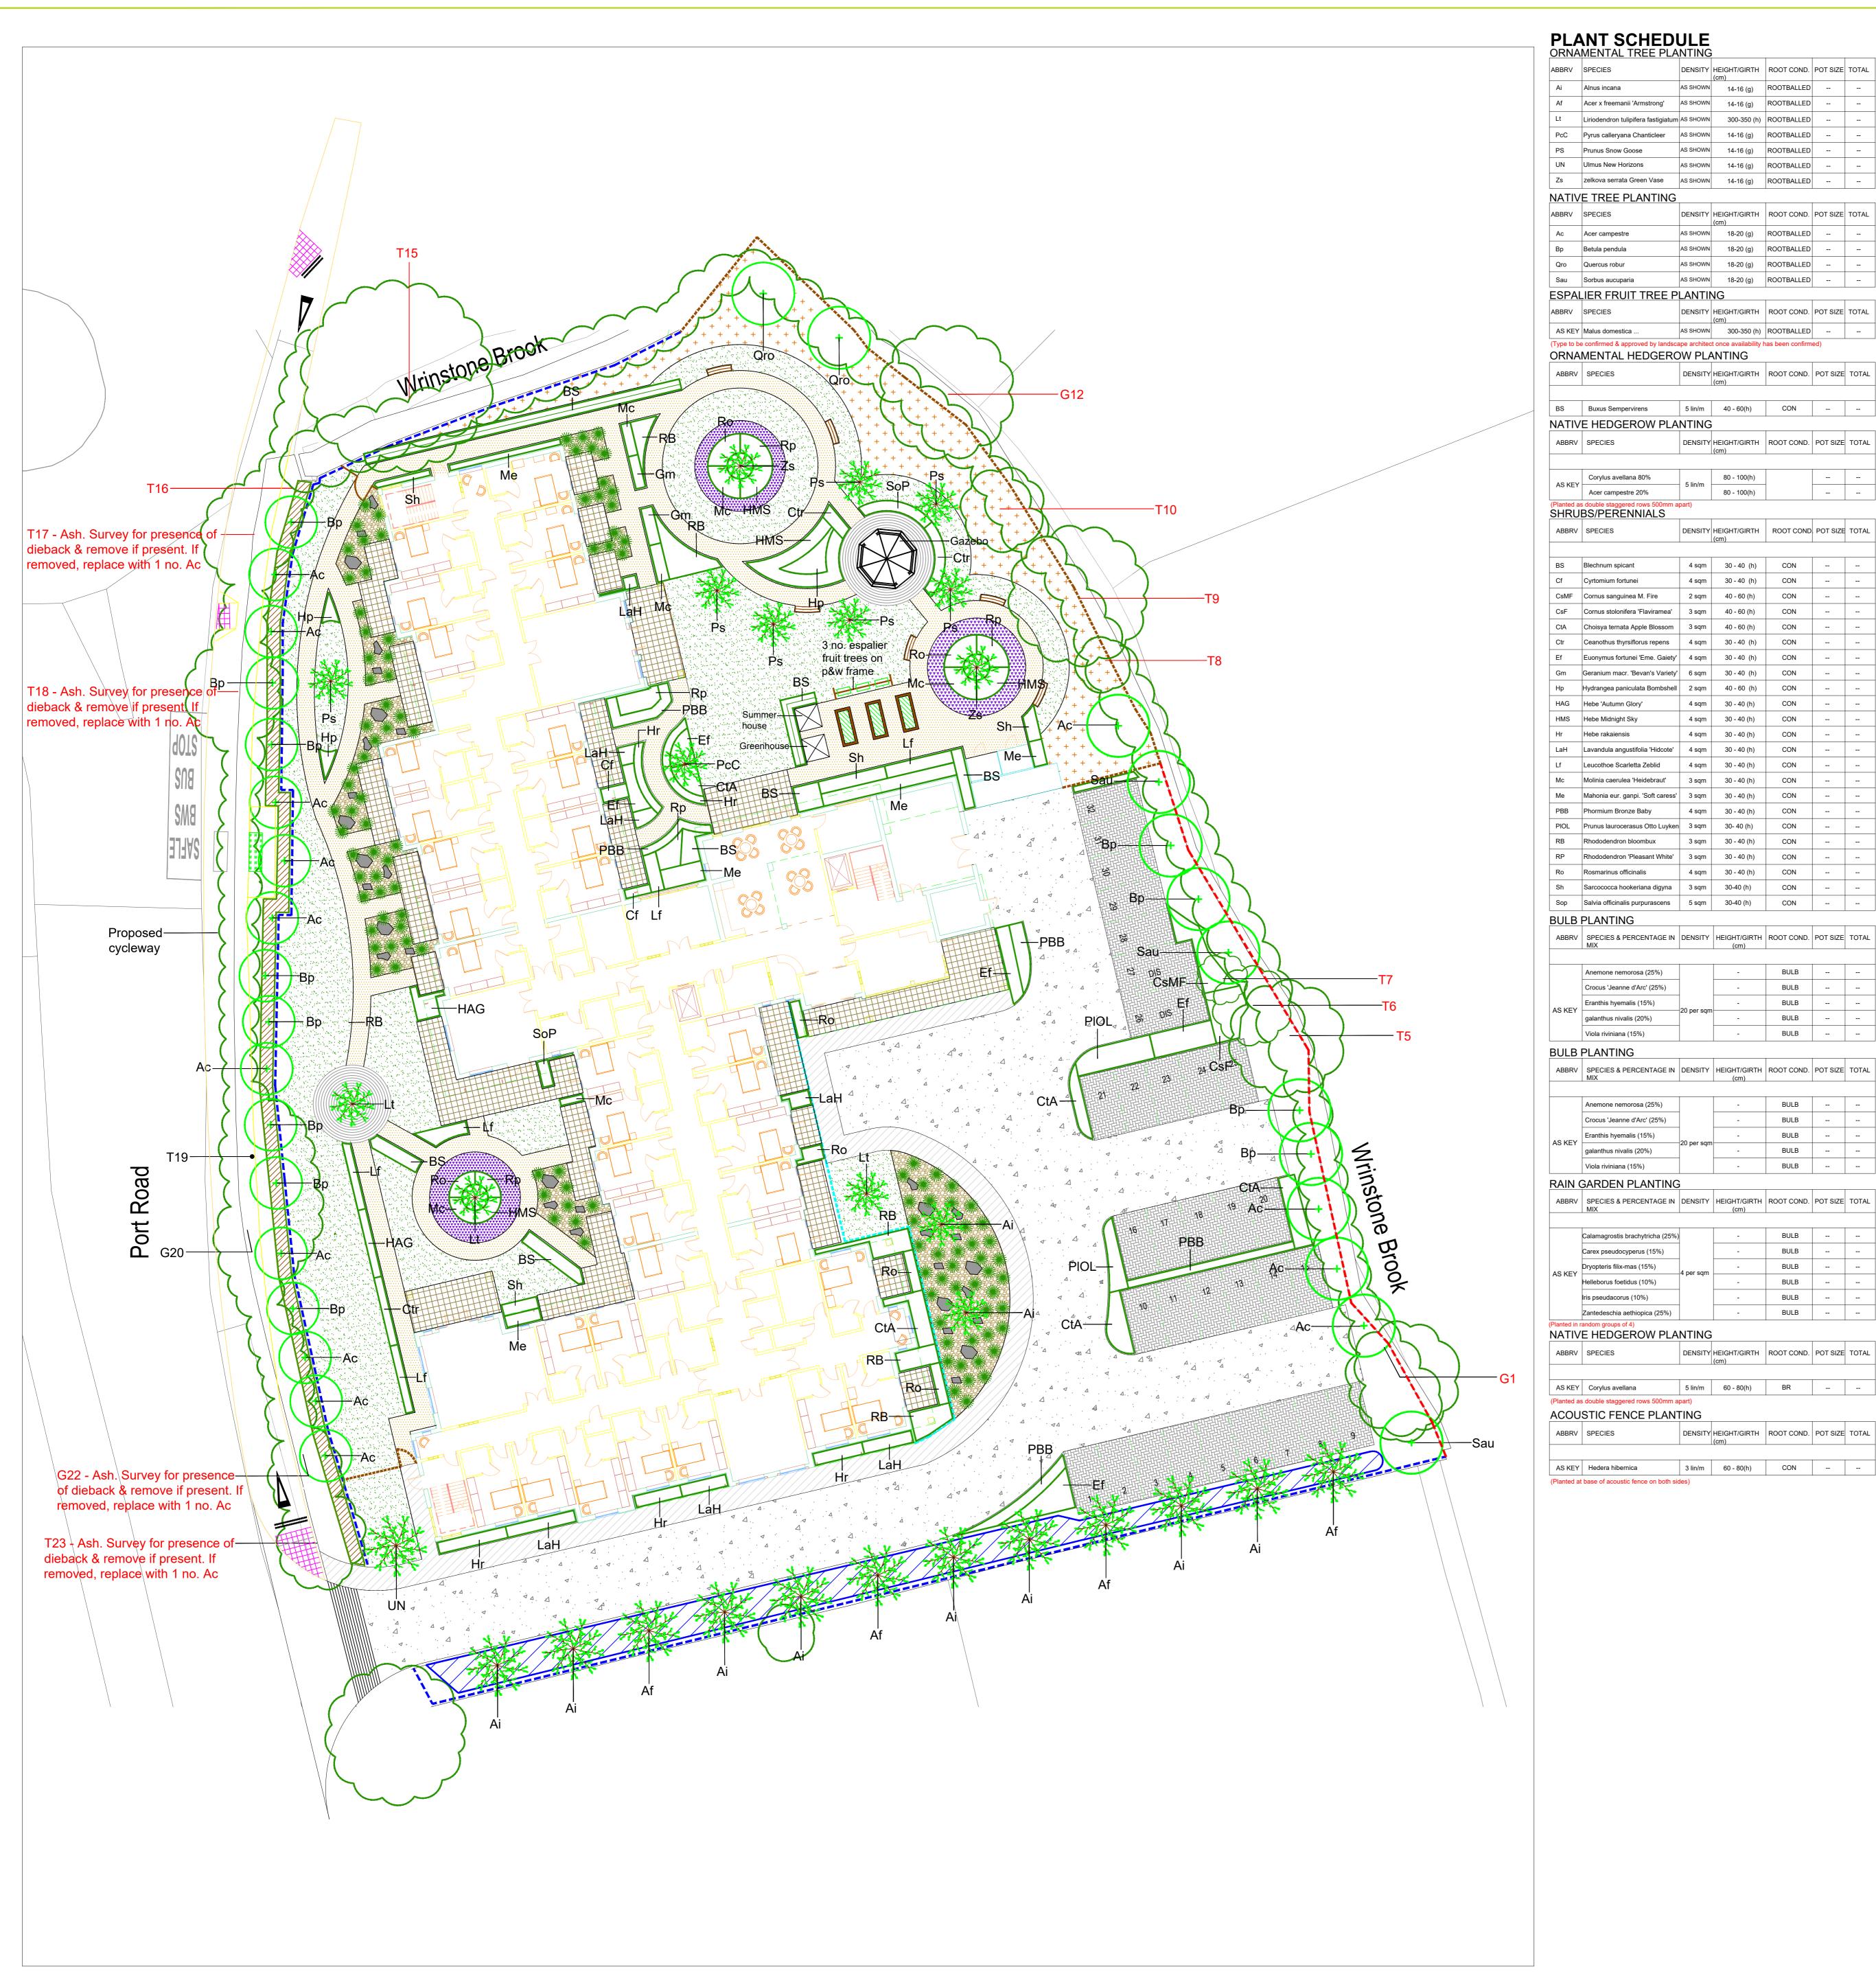

PLANT SCHEDULE ORNAMENTAL TREE PLANTING

ABBRV	SPECIES	DENSITY	HEIGHT/GIRTH (cm)	ROOT COND.	POT SIZE	TOTAL
Ai	Alnus incana	AS SHOWN	14-16 (g)	ROOTBALLED		
Af	Acer x freemanii 'Armstrong'	AS SHOWN	14-16 (g)	ROOTBALLED		
Lt	Liriodendron tulipifera fastigiatum	AS SHOWN	300-350 (h)	ROOTBALLED		
PcC	Pyrus calleryana Chanticleer	AS SHOWN	14-16 (g)	ROOTBALLED		
PS	Prunus Snow Goose	AS SHOWN	14-16 (g)	ROOTBALLED		
UN	Ulmus New Horizons	AS SHOWN	14-16 (g)	ROOTBALLED		-
Zs	zelkova serrata Green Vase	AS SHOWN	14-16 (g)	ROOTBALLED		

NATIVE TREE PLANTING

ABBRV	SPECIES	DENSITY	HEIGHT/GIRTH (cm)	ROOT COND.	POT SIZE	TOTAL
Ac	Acer campestre	AS SHOWN	18-20 (g)	ROOTBALLED		
Вр	Betula pendula	AS SHOWN	18-20 (g)	ROOTBALLED		
Qro	Quercus robur	AS SHOWN	18-20 (g)	ROOTBALLED		
Sau	Sorbus aucuparia	AS SHOWN	18-20 (g)	ROOTBALLED		

ESPALIER FRUIT TREE PLANTING

DENSITY HEIGHT/GIRTH ROOT COND. POT SIZE TOTAL AS SHOWN 300-350 (h) ROOTBALLED AS KEY Malus domestica ...

	ABBRV	SPECIES	DENSITY	HEIGHT/GIRTH (cm)	ROOT COND.	POT SIZE	TOTAL	
	BS	Buxus Sempervirens	5 lin/m	40 - 60(h)	CON			
	NATIV	E HEDGEROW PLA	NTING					
	ABBRV	SPECIES	DENSITY	HEIGHT/GIRTH (cm)	ROOT COND.	POT SIZE	TOTAL	

AO RET	Acer campestre 20%	0	80 - 100(h)			
	s double staggered rows 500mm a BS/PERENNIALS	part)				
ABBRV	SPECIES	DENSITY	HEIGHT/GIRTH (cm)	ROOT COND	POT SIZE	TOTAL
BS	Blechnum spicant	4 sqm	30 - 40 (h)	CON		
Cf	Cyrtomium fortunei	4 sqm	30 - 40 (h)	CON		
CsMF	Cornus sanguinea M. Fire	2 sqm	40 - 60 (h)	CON		
CsF	Cornus stolonifera 'Flaviramea'	3 sqm	40 - 60 (h)	CON		
CtA	Choisya ternata Apple Blossom	3 sqm	40 - 60 (h)	CON		

Cf	Cyrtomium fortunei	4 sqm	30 - 40 (h)	CON	
CsMF	Cornus sanguinea M. Fire	2 sqm	40 - 60 (h)	CON	
CsF	Cornus stolonifera 'Flaviramea'	3 sqm	40 - 60 (h)	CON	
CtA	Choisya ternata Apple Blossom	3 sqm	40 - 60 (h)	CON	
Ctr	Ceanothus thyrsiflorus repens	4 sqm	30 - 40 (h)	CON	
Ef	Euonymus fortunei 'Eme. Gaiety'	4 sqm	30 - 40 (h)	CON	
Gm	Geranium macr. 'Bevan's Variety'	6 sqm	30 - 40 (h)	CON	
Нр	Hydrangea paniculata Bombshell	2 sqm	40 - 60 (h)	CON	
HAG	Hebe 'Autumn Glory'	4 sqm	30 - 40 (h)	CON	
HMS	Hebe Midnight Sky	4 sqm	30 - 40 (h)	CON	
Hr	Hebe rakaiensis	4 sqm	30 - 40 (h)	CON	
LaH	Lavandula angustifolia 'Hidcote'	4 sqm	30 - 40 (h)	CON	
Lf	Leucothoe Scarletta Zeblid	4 sqm	30 - 40 (h)	CON	

4 sqm 30 - 40 (h) CON

4 sqm | 30 - 40 (h) | CON Sh Sarcococca hookeriana digyna 3 sqm 30-40 (h) CON Sop Salvia officinalis purpurascens 5 sqm 30-40 (h) CON -- --

	ABBRV	SPECIES & PERCENTAGE IN MIX	DENSITY	HEIGHT/GIRTH (cm)	ROOT COND.	POT SIZE	TOTAL
				, ,			
		Anemone nemorosa (25%)		-	BULB		
		Crocus 'Jeanne d'Arc' (25%)		-	BULB		
	AS KEY	Eranthis hyemalis (15%)	00	-	BULB		
	AS KEY	galanthus nivalis (20%)	20 per sqm	-	BULB		
		Viola riviniana (15%)		-	BULB		

BULB PLANTING

ADDITV	MIX	DENSIT	(cm)	ROOT COND.	POT SIZE	TOTAL
	Anemone nemorosa (25%)		-	BULB		
	Crocus 'Jeanne d'Arc' (25%)		-	BULB		
AS KEY	Eranthis hyemalis (15%)	00	-	BULB		
AS KEY	galanthus nivalis (20%)	20 per sqm	-	BULB		
	Viola riviniana (15%)		-	BULB		

RAIN GARDEN PLANTING

/ LDDI (V	OF EOILO & FEROLITINOL III	DENOTE	IILIOIII/OIIVIII	INCOT COND.	1 01 0122	101/L
	MIX		(cm)			
	Calamagrostis brachytricha (25%)		-	BULB		
	Carex pseudocyperus (15%)	-4 per sqm	-	BULB		
	Dryopteris filix-mas (15%)		_	BULB		
AS KEY	Bryoptono mix mao (1070)			BOLD		
, to ItL	Helleborus foetidus (10%)		_	BULB		
	` ,					
	Iris pseudacorus (10%)	_	-	BULB		
	Zantedeschia aethiopica (25%)		_	BULB		
	Zariteuescriia aetriiopica (25%)			DOLD		

anted in r	nted in random groups of 4)										
ATIVE HEDGEROW PLANTING											
ABBRV	SPECIES	DENSITY		ROOT COND.	POT SIZE	TOTAL					
			(cm)								
AS KEY	Corylus avellana	5 lin/m	60 - 80(h)	BR							
	· · · · · · · · · · · · · · · · · ·	•,									

3 lin/m 60 - 80(h) CON -- --

DENSITY HEIGHT/GIRTH ROOT COND. POT SIZE TOTAL


LANDSCAPE KEY:



EXISTING BOUNDARY HEDGEROW & ASSOCIATED TREES (Thin spots / gaps to be infilled with new native planting. Refer to plant schedule for species / densities)



PROPOSED ORNAMENTAL TREE PLANTING (Refer to schedule for species)

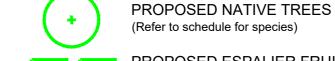

PROPOSED ESPALIER FRUIT TREES (Refer to schedule for species)




PROPOSED WILDFLOWER 1 (Emorsgate EM1 - Wildflower Mix)


PROPOSED SHRUB PLANTING




(Refer to schedule for species/densities) PROPOSED TURF AREAS

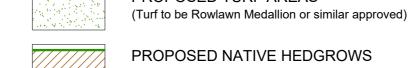

(Refer to schedule for species/densities) PROPOSED RAIN GARDEN SURFACED WITH PEBBLE SCREE WITH FEATURE BOULDERS

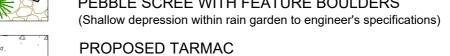


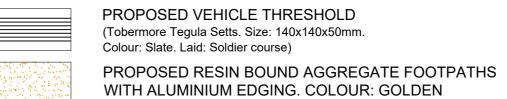



PROPOSED PARKING BAY PAVING (Tobermore Hydropave Fusion. Size: 200x100x80mm. Colour: Silver)

(Tobermore Textured Flag Paviours. Size: 450x450x50mm. Colour: Buff)

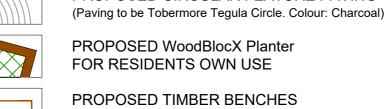

PROPOSED TIMBER BENCHES (Size and type to be agreed)

PROPOSED CIRCULAR FEATURE PAVING

PROPOSED 1.8m HIGH CLOSE BOARDED TIMBER FENCE PROPOSED 1.2 HIGH BALL TOP RAILINGS

(Type to be agreed) PROPOSED 2.0m ACOUSTIC FENCE (Both sides of fence to be planted with climbing plants.

Refer to plant schedule for species / densities) PROPOSED 1.2m HIGH TIMBER POST & RAIL FENCE

PLANTING PALETTE

































To avoid any damage associated with construction operations, all soft landscape works are to be undertaken during the first available planting season following practical completion of the hard landscaping

All planting stock shall be to BS3936:1992 - Nursery Stock -Part 1. Refer to specification & management plan for planting & aftercare details.

from carriageway Proposed native trees within open ground to be planted

Proposed ornamental trees to be set a minimum of 1m back

with mowing guards. This drawing was produced at 1:250 @ A1 and is a colour drawing. Do not rely on reduced or monochrome copies

Acoustic fence and planting added

LLANGAN CF35 5DN

THE GRANARY NEWLAND FAWR FARM TEL: 01446 789367




AMP 06.11.20

CASTLEOAK

GLENBURNIE, WENVOE

DETAILED LANDSCAPE & BOUNDARY PROPOSALS WITH PROPOSED CYCLEWAY

2019/01177/FUL

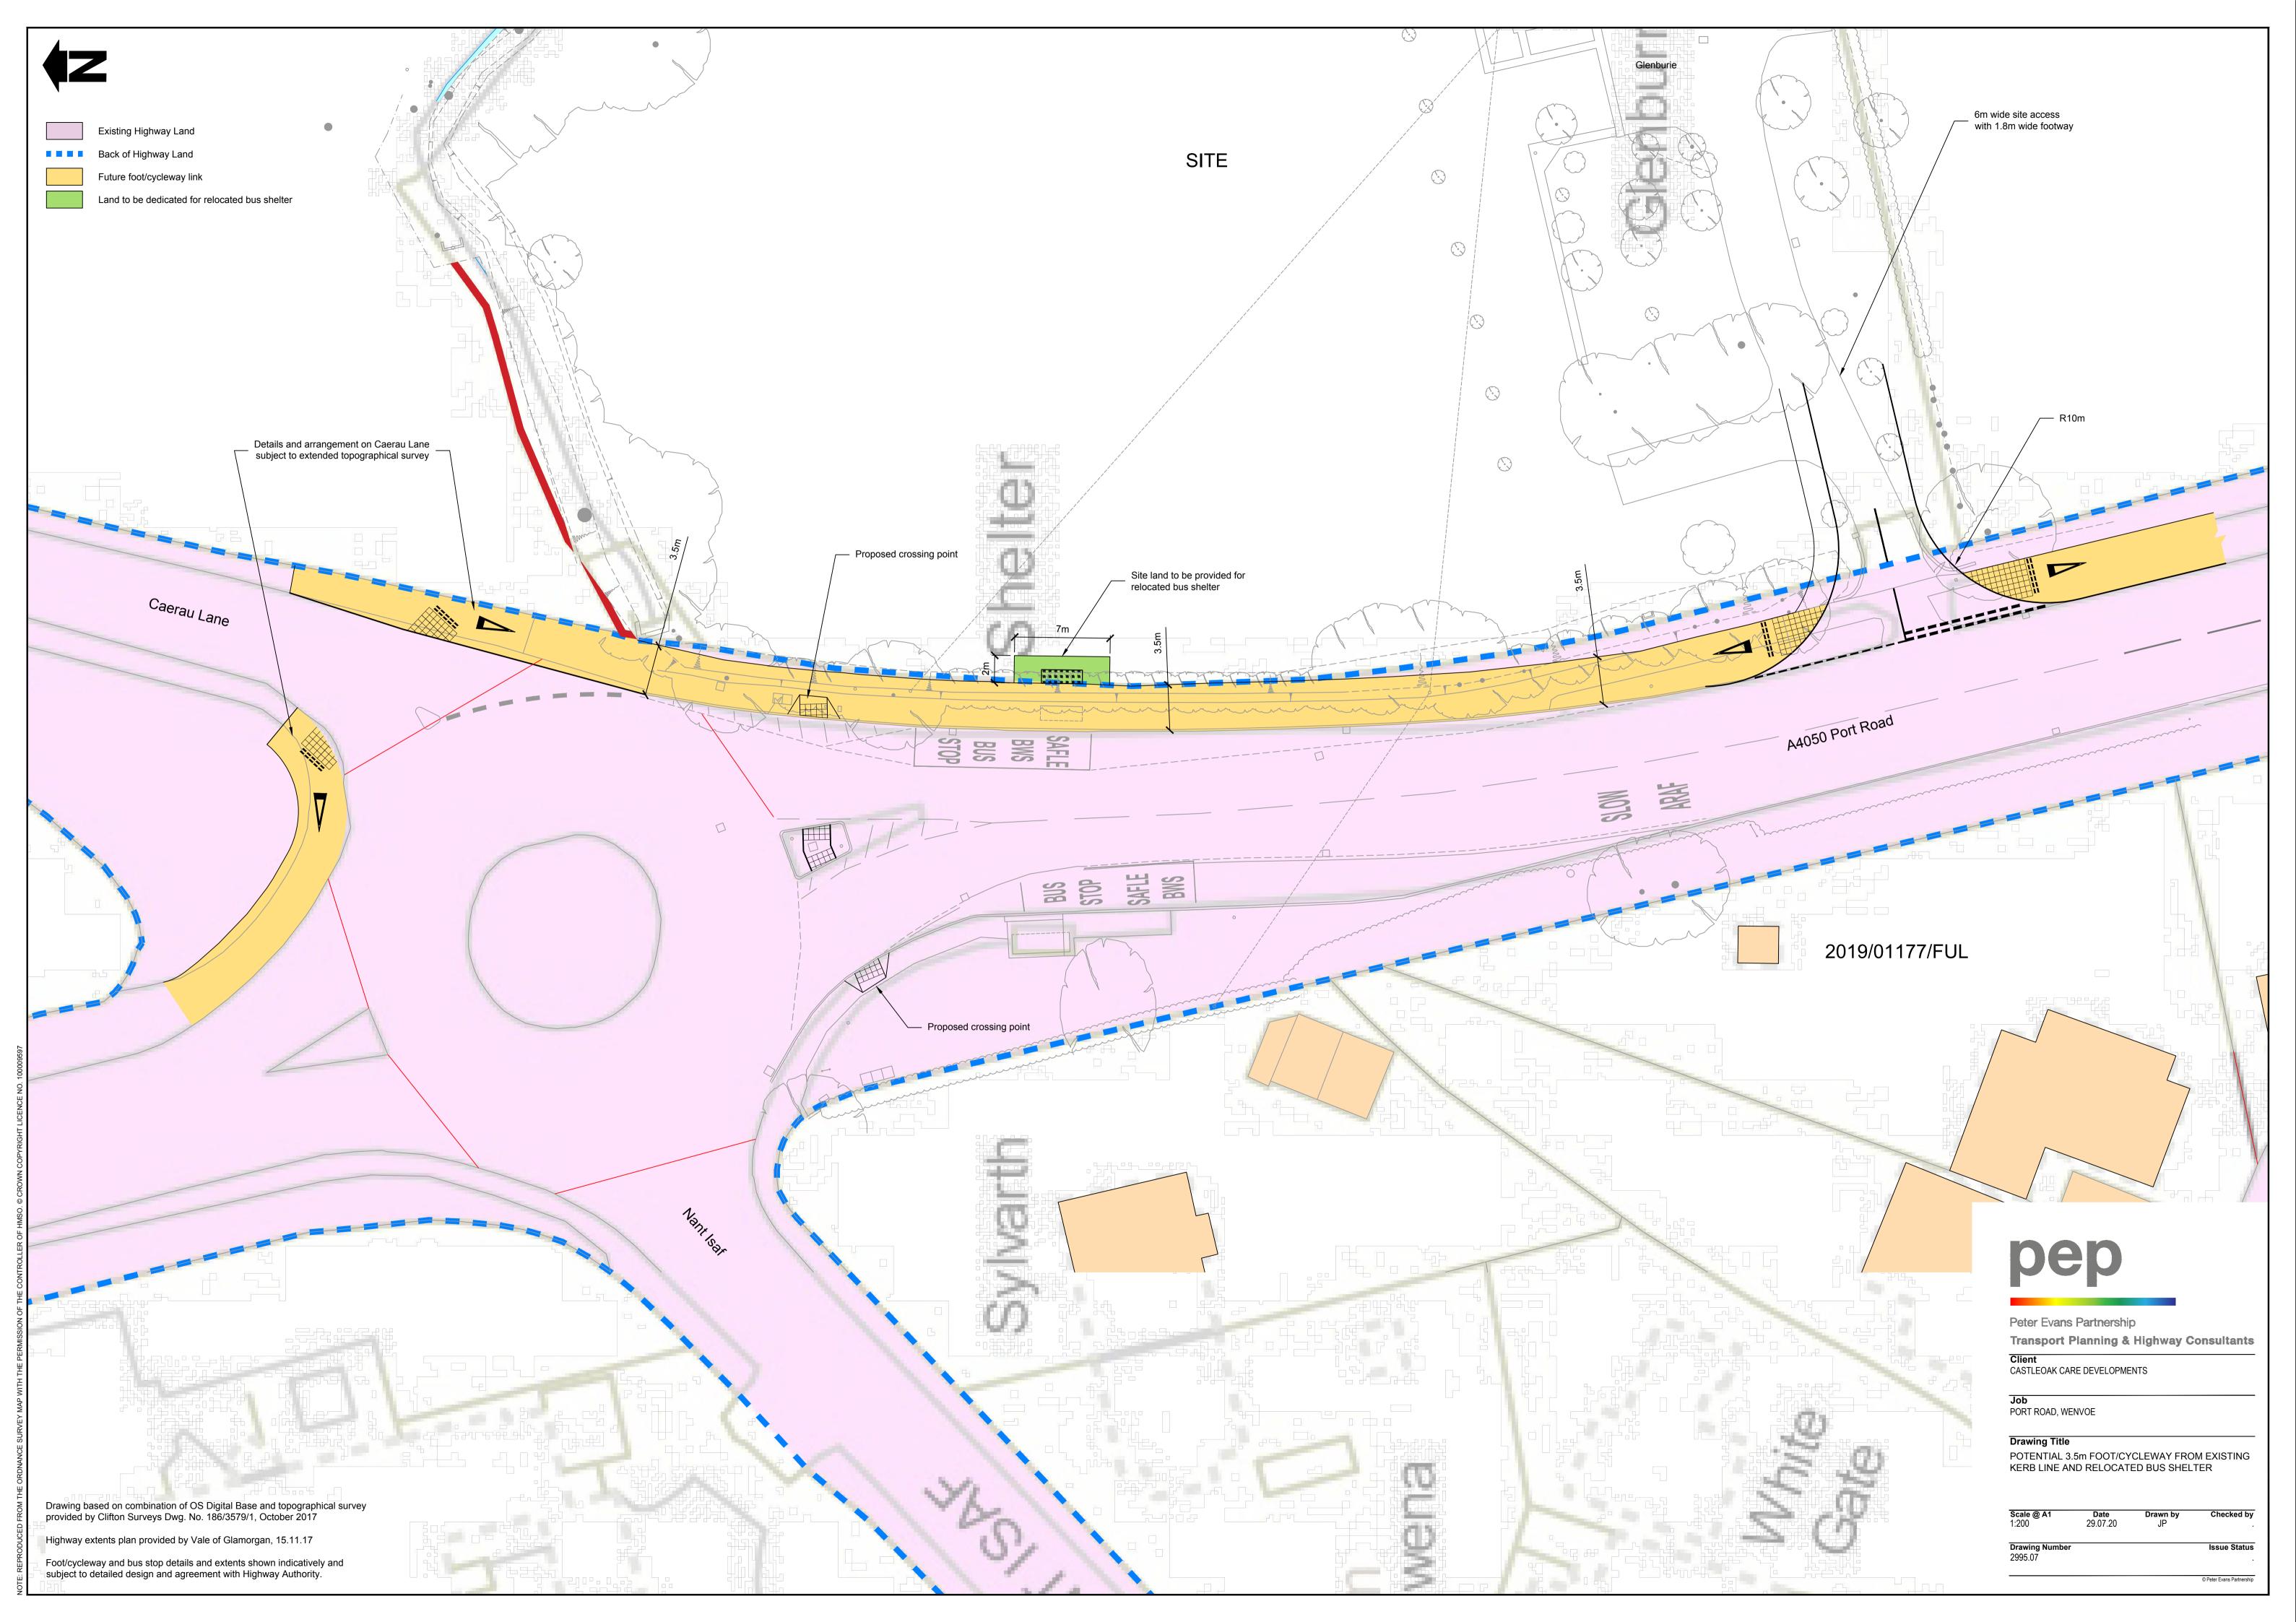

0m 2.5m 5m 7.5m 10m 12.5m

VISUAL SCALE 1:125 @ A1

NOTES

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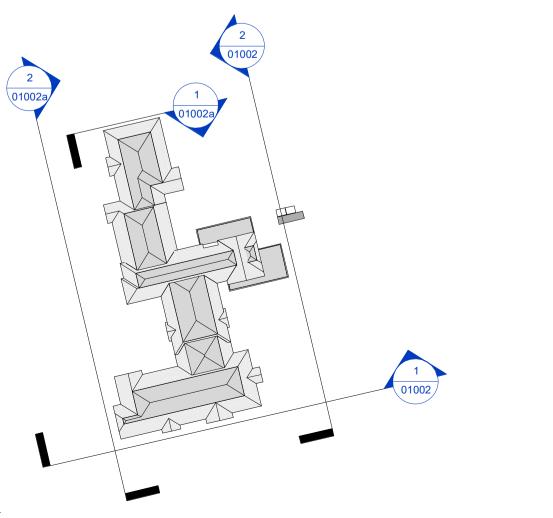
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2019/01177/FUL



Project:
Proposed Care Home
Sanderstead Port Road
Wenvoe
CF5 6AB
Client:

Drawing Title:
Proposed Elevations (Sheet 1 of 2)

For Planning Submission

HA Project Number Scale @ A1 Suitability

2306 As indicated D0

Project Originator Volume Level Type Role Number

2306 - HIA - ZZ - XX - DR - A - 01002

27001-Key 1:1000

NOTES

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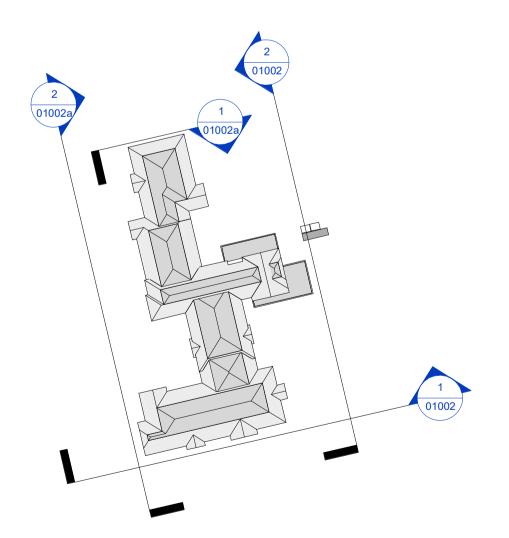
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West Elevation
1: 125



North Elevation
1: 125



2019/01177/FUL



3 27001-Key Copy 1 1:1000



Existing dwelling and access from Port Road



Existing dwelling and access from Port Road



View from Port Road / Caerau Lane Junction



View of Premier Inn / Beefeater on west side of Port Road



View of site from Premier Inn / Beefeater on west side of Port Road





View of site to north from Port Road



Existing

The majority of the proposed development is screened by existing trees and vegetation combined with the proposed boundary tree planting.

Limited views of the proposals are possible from this viewpoint. It should however be noted that existing residential properties are clearly visible above the roof-line of the proposed development. Views of the development will therefore be largely in keeping with the established context and the development is not considered to be visually incongruous



Proposed



Existing

Almost all of the proposed development is screened by existing trees and vegetation. Small glimpses of the roof-line are possible from this viewpoint however, possible views are so narrow that any visual impact is negligible. In addition to this it should be noted that the site will be viewed in the context of the existing residential properties at Brookside and Caerau Lane. Views of the development will therefore be largely in keeping with the established context and the development is not considered to be visually incongruous



Proposed



Existing

Almost all of the proposed development is screened by existing trees and vegetation combined with the proposed boundary soft landscaping. Very small glimpses of the building are possible from this viewpoint but due to the existing and proposed screening, any visual impact is negligible



Proposed



Existing

The care home development is clearly visible from this viewpoint. However, it should be noted that the view is immediately adjacent to the site entrance, as such any visual impact is highly localised. The proposed tree will significantly reduce the adverse visual impact



Proposed



Existing

The care home development is not visible from this viewpoint



Proposed



Proposed View in year 1 with new cycleway footway



Proposed Internal View